

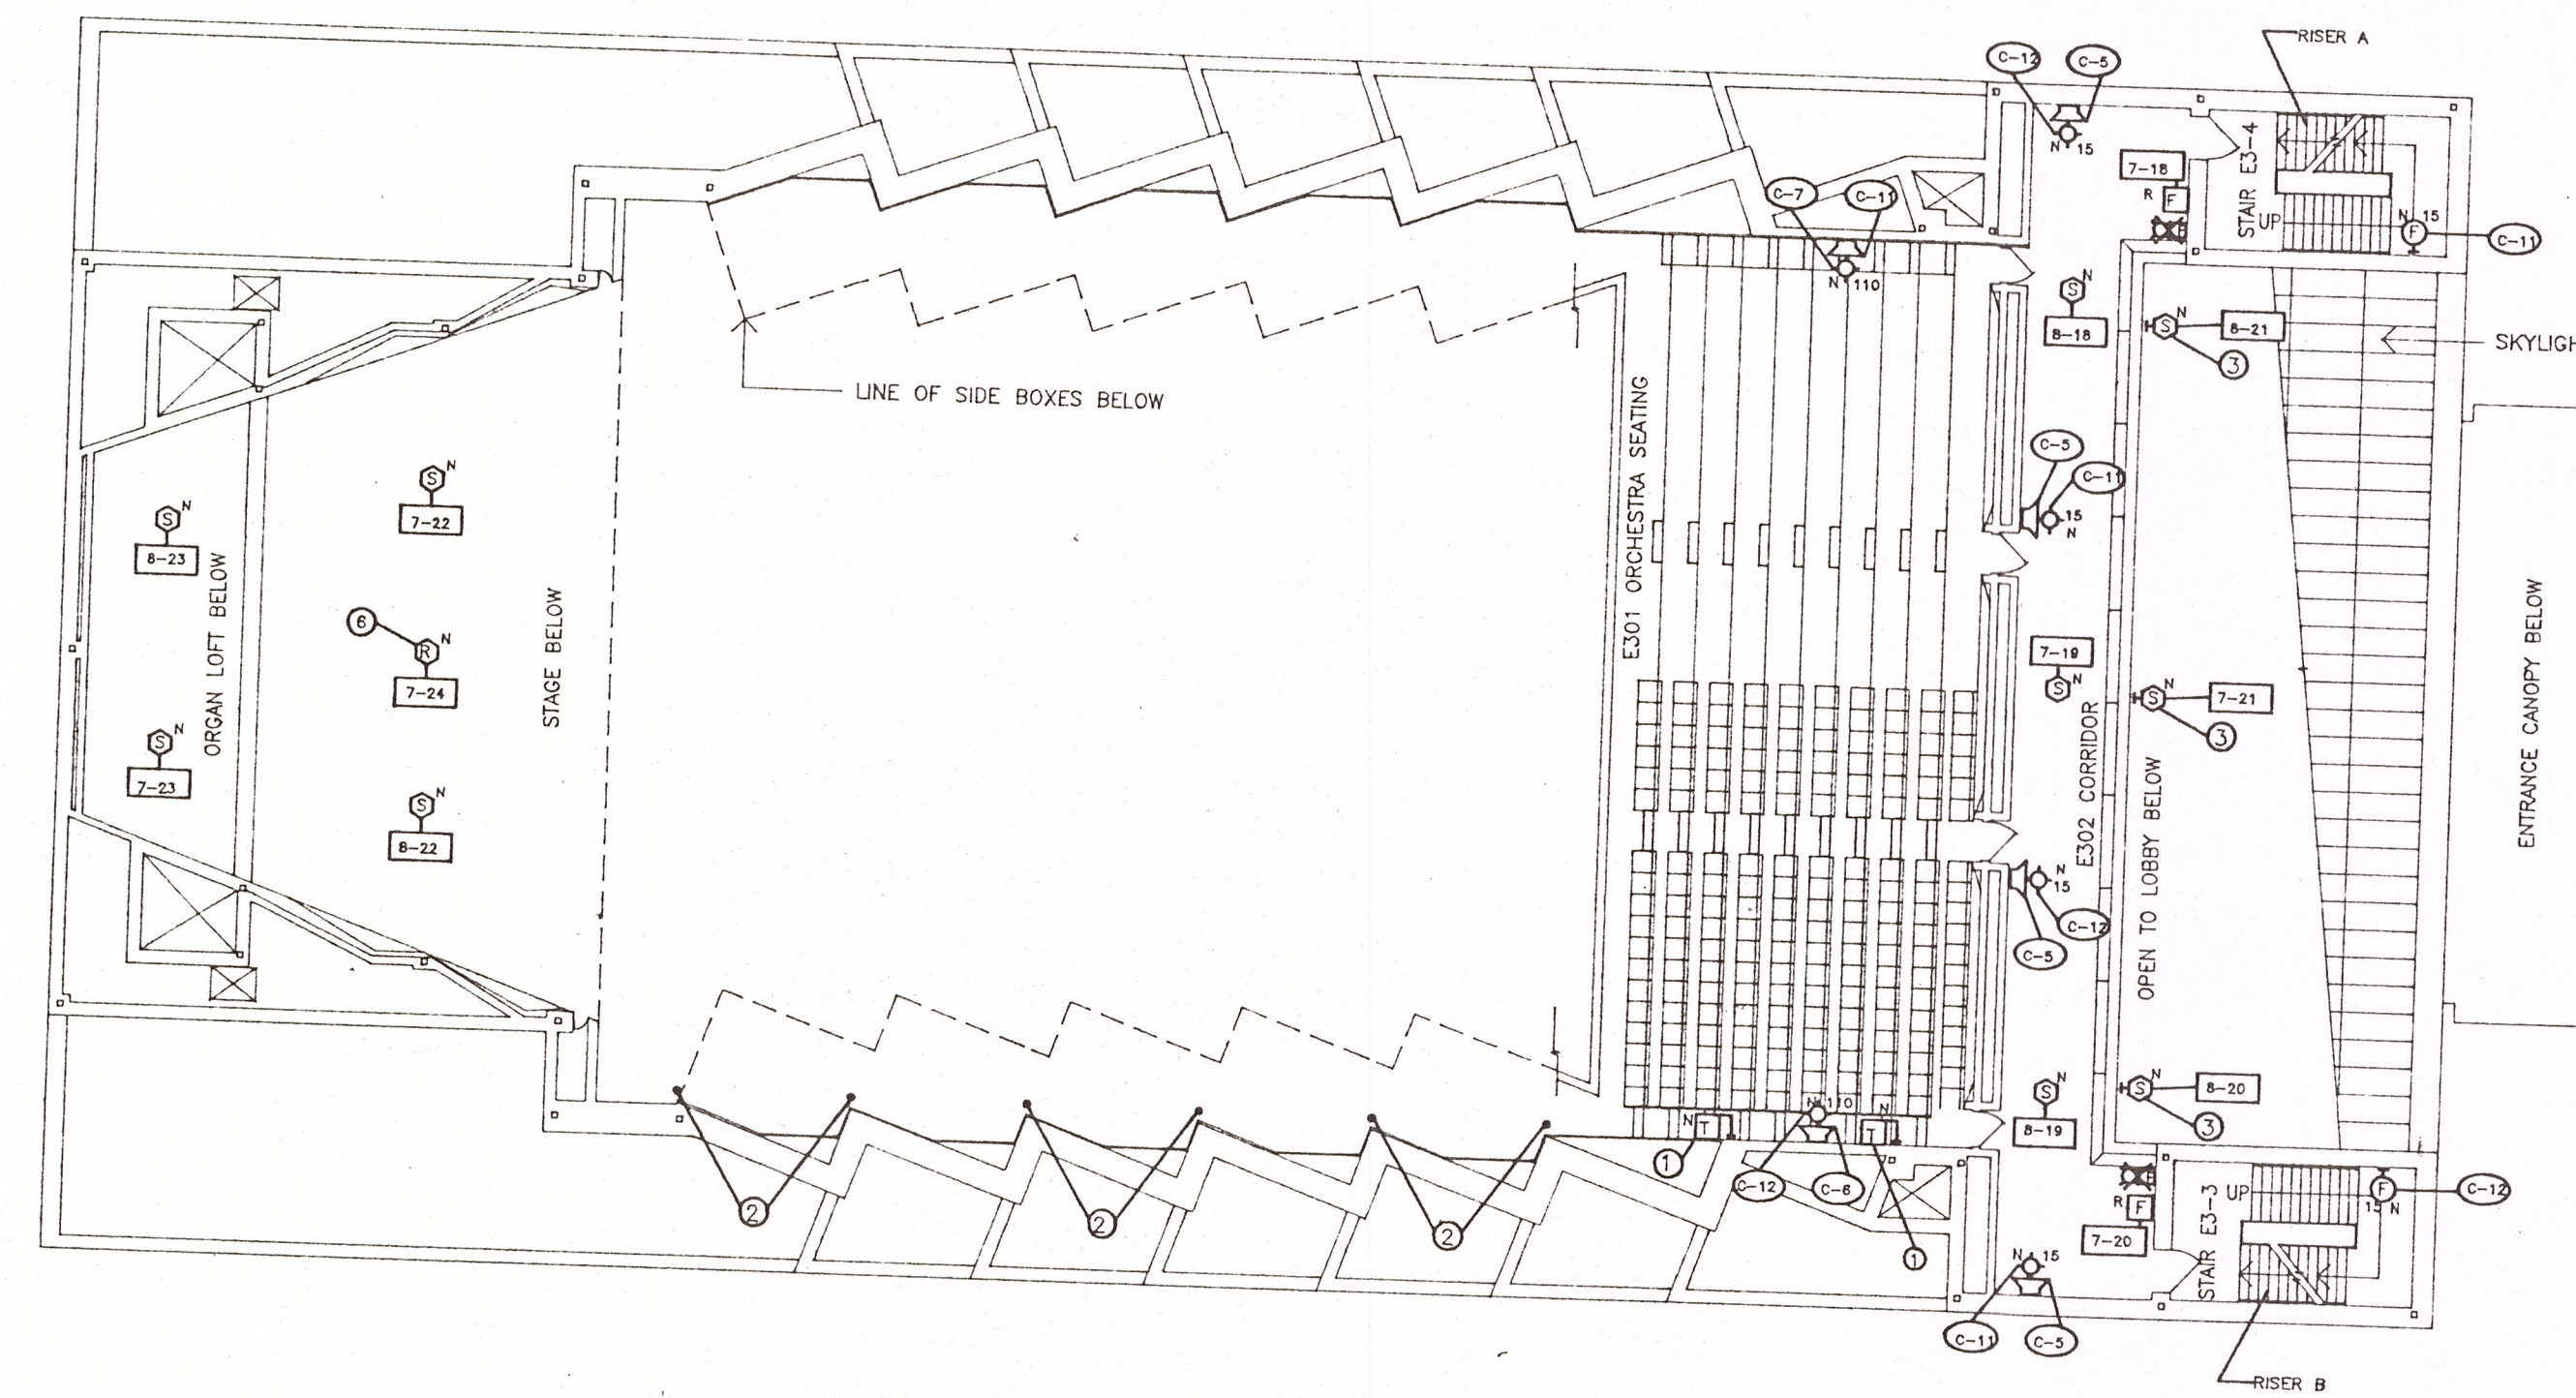


1 PLAN AT BOX LEVEL - LEVEL 2.4
A8 SCALE: 1/16" = 1'-0"

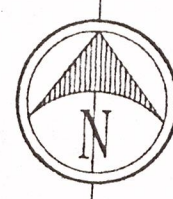



2 BALCONY PLAN - LEVEL 3.1
A8 SCALE: 1/16" = 1'-0"

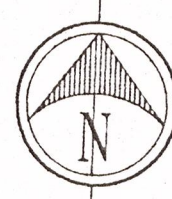

- KEY NOTES:**
- 1 TEST STATION FOR BEAM SMOKE DETECTOR; WIRE TO DETECTOR ABOVE; SEE DETAIL.
 - 2 WIRING FROM BEAM DETECTOR ABOVE TO TEST STATION BELOW. RUN CONCEALED.
 - 3 WALL MOUNT 9 INCHES BELOW TOP OF SKYLIGHT.
 - 4 REWIRE EXISTING DOOR HOLDER TO NEW FIRE ALARM SYSTEM. SEE RISER DIAGRAM AND DETAIL.
 - 5 WIRE TO (FUTURE) SMOKE HATCH AS NOTED. SEE DETAIL. FOR EXISTING HATCHES, REMOVE EXISTING CONTROL; MAINTAIN POWER SUPPLY.
 - 6 FOR FUTURE STAGE SMOKE VENT(S), SEE DETAIL.


CONTRACTOR SHALL CHECK AND FIELD VERIFY ALL DIMENSIONS AND REPORT DISCREPANCIES TO THE ARCHITECT BEFORE ANY WORK IS COMMENCED.
ALL DRAWINGS ARE THE PROPERTY OF THE ARCHITECT.
THIS DESIGN AND THESE DOCUMENTS MAY NOT BE REPRODUCED, REUSED, ALTERED OR ADDED TO WITHOUT THE WRITTEN PERMISSION OF THE ARCHITECT.

STATE UNIVERSITY
CONSTRUCTION FUND
SUCF PROJECT NUMBER 12130
REPLACE FIRE ALARM SYSTEM / INSTALL SPRINKLER
CRANE MUSIC COMPLEX
STATE UNIVERSITY COLLEGE AT POTSDAM

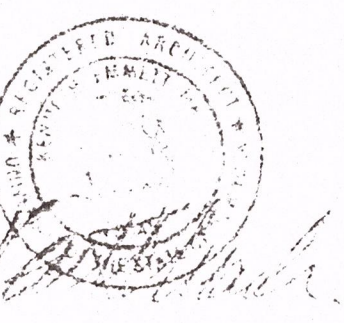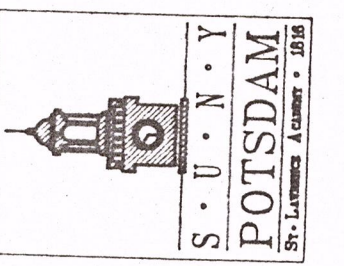

HAZP, CONSULTANTS IN ENGINEERING
P.O. BOX 226
CLIFTON PARK, NY, 12085
TEL: (518) 877-8566
FAX: (518) 877-8566

OCM PROJECT NO. 10233

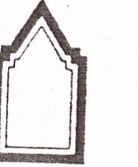

O'CONNOR & MARSH
ARCHITECTS

FACILITY DESIGN - PLANNING

517 OVER THE LIBRARY
WESTERN AVENUE
ALBANY, NEW YORK 12203
518 458 0611

DRAWING TITLE
HOSMER CONCERT HALL -
LEVEL 2.4, &
LEVEL 3.1

DATE
12-9-97

DRAWING NO.
A8

SUCF PROJECT NO.
12130

HOSMER CONCERT HALL (BLDG. NO. 16)

D116